PROPOSED RESIDENCE

7 DE SALIS DRIVE, JUNEE NSW 2663

LOT 22 DP 811541 LOT SIZE - ≈4710m² LGA: JUNEE SHIRE

DESIGNED FOR: SHEATHER

DRAWING SCHEDULE:

NO. TITLE A00 SITE PLAN A01 **ROOF PLAN**

A02 GROUND FLOOR PLAN

A03 FIRST FLOOR PLAN

A04 SECTION A05 **ELEVATIONS**

A06 **ELEVATIONS** GLAZING SCHEDULE + BASIX A07

BUILDING NOTES

ALL DIMENSIONS TO BE CHECKED ON SITE PRIOR TO COMMENCEMENT OF WORKS, WRITTEN DIMENSIONS TAKE PRECEDENCE OVER SCALING. THESE PLANS ARE TO BE READ IN CONJUNCTION WITH ALL OTHER ASSOCIATED DOCUMENTS. LEVELS SHOWN ARE RELATIVE ONLY.

BUILDER TO ENSURE ALL UNDERGROUND SERVICES, PIPES AND CABLES TO BE LOCATED PRIOR TO EXCAVATION. CALL 'DIAL BEFORE YOU DIG' ON 1100 OR GO TO www.1100.com.au

SITE: THE BUILDER SHALL SUPPLY/INSTALL AND MAINTAIN THE FOLLOWING IN ACCORDANCE WITH LOCAL COUNCIL AUTHORITY:

- SEDIMENT CONTROL MEASURES
- STABILISED ENTRY POINT CONTROLLED RUBBISH AREA
- TOILET FACILITIES

COMPLIANCE: ALL BUILDING WORK TO COMPLY WITH THE 'NATIONAL CONSTRUCTION CODE' OF AUSTRALIA 2022, AND ANY REFERENCED AUSTRALIAN STANDARDS AND LOCAL COUNCIL AUTHORITY REQUIREMENTS. ALL AREAS TO BE MADE GOOD BY THE BUILDER WHERE DISTURBED BY THE NEW WORK.

BASIX: BASIX - ALL SELECTIONS TO COMPLY WITH ENERGY EFFICIENCY PERFORMANCE REQUIREMENTS OF THE ASSOCIATED BASIX CERTIFICATE. CONCRETE: ALL CONCRETE SLAB & FOOTINGS FOR CLASS 1 & 10a BUILDINGS TO COMPLY WITH AS 2870 'RESIDENTIAL SLAB & FOOTINGS'.

STORMWATER: DESIGN AND INSTALLATION TO COMPLY WITH AS/NZS 3500.3 -2003 (PLUMBING AND DRAINAGE - STORMWATER DRAINAGE) OR AS/NZS 3500.5 -2000 (NATIONAL PLUMBING AND DRAINAGE DOMESTIC INSTALLATIONS)


SEWER: DESIGN AND INSTALLATION TO COMPLY WITH AS/NZS 3500.2 - 2003 (PLUMBING AND DRAINAGE - SANITARY PLUMBING AND DRAINAGE) OR AS/NZS

TERMITE PROTECTION: PROVIDE PHYSICAL AND CHEMICAL TERMITE BARRIERS IN ACCORDANCE WITH THE NCC 2022 VOL 2, PART 3.4 TERMITE RISK MANAGEMENT' AND AS 3660.1.

MASONRY: TO BE IN ACCORDANCE WITH AS 3700 (MASONRY STRUCTURES). ELECTRICAL: DESIGN AND INSTALLATION TO COMPLY WITH AS/NZS 3018 -2001 (ELECTRICAL INSTALLATIONS - DOMESTIC INSTALLATIONS)

WET AREA WATERPROOFING: TO BE IN ACCORDANCE WITH THE NCC VOL 2 PART 10.2 'WET AREA WATERPROOFING'. EXTERNAL WATERPROOFING AND MATERIALS SELECTION, SYSTEM DESIGN AS PER AS 4654

GLAZING: SELECTION AND INSTALLATION TO AS 2047 AND GLASS TYPE AND THICKNESS TO AS 1288. ALL OTHER COMPONENTS TO COMPLY WITH RELATIVE STANDARDS.

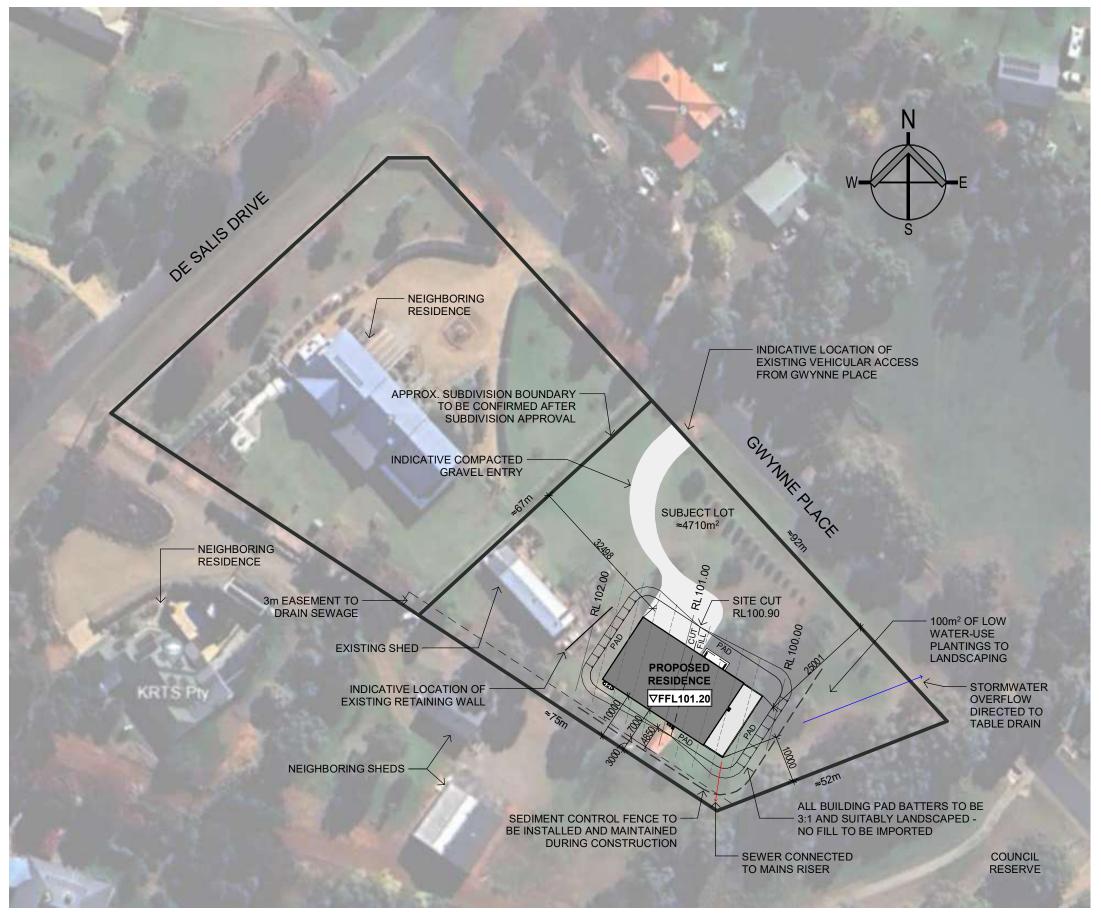

SITE PLAN **SCALE AT A3 1:800**




PROJECT PROPOSED RESIDENCE 7 DE SALIS DRIVE JUNEE NSW

DRAWING TITLE SITE PLAN CLIENT **SHEATHER** DATE // TIME 28/01/2025 9:54:21 AM **SCALE AS SHOWN** REVISION NO. PROJECT ID 35FED24





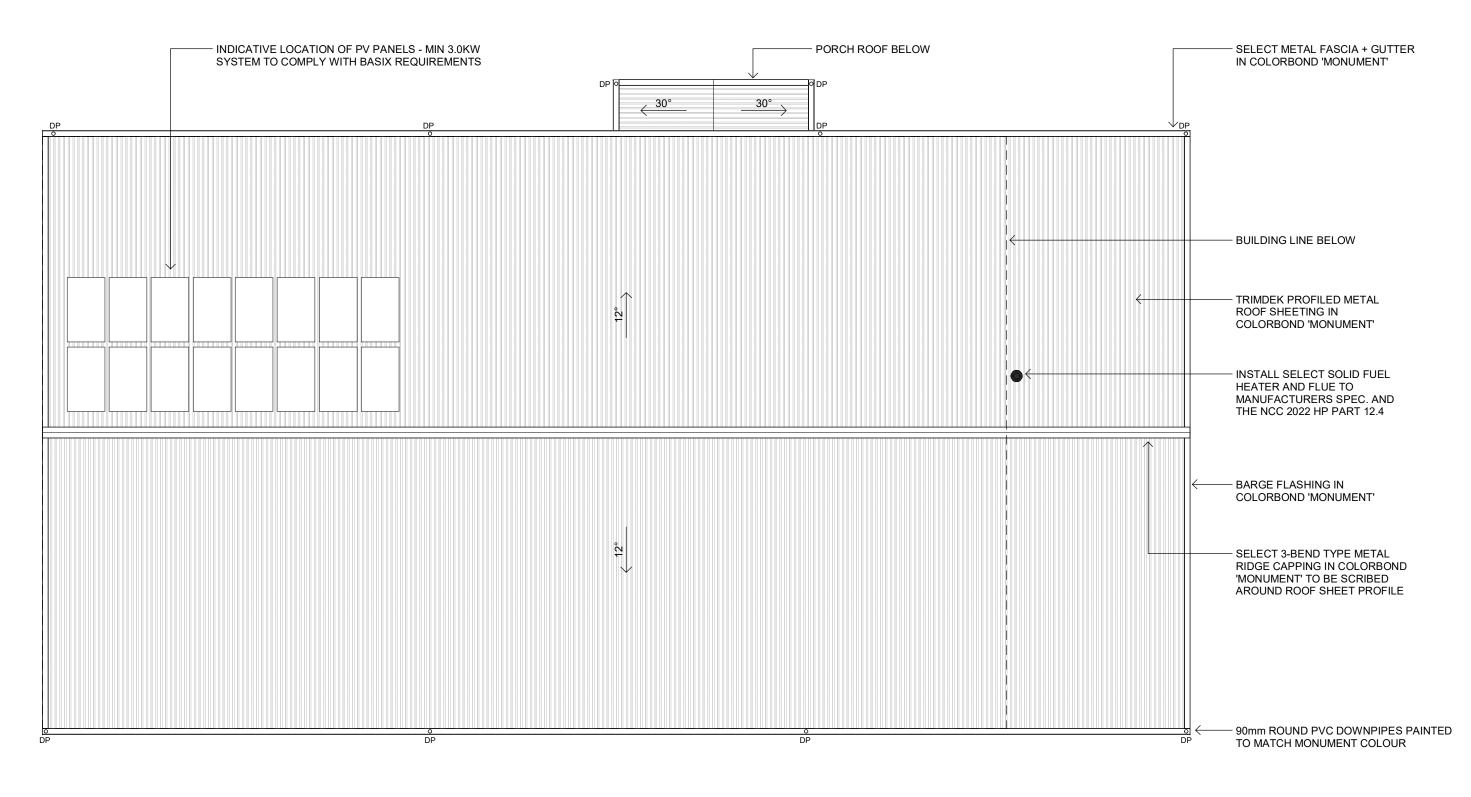

ROOF PLAN SCALE AT A3 1:100



PROJECT
PROPOSED RESIDENCE
7 DE SALIS DRIVE
JUNEE NSW


DRAWING TITLE
ROOF PLAN
CLIENT
SHEATHER
DATE // TIME
28/01/2025 9:54:22 AM

REVISION NO.

A

PROJECT ID
35FED24



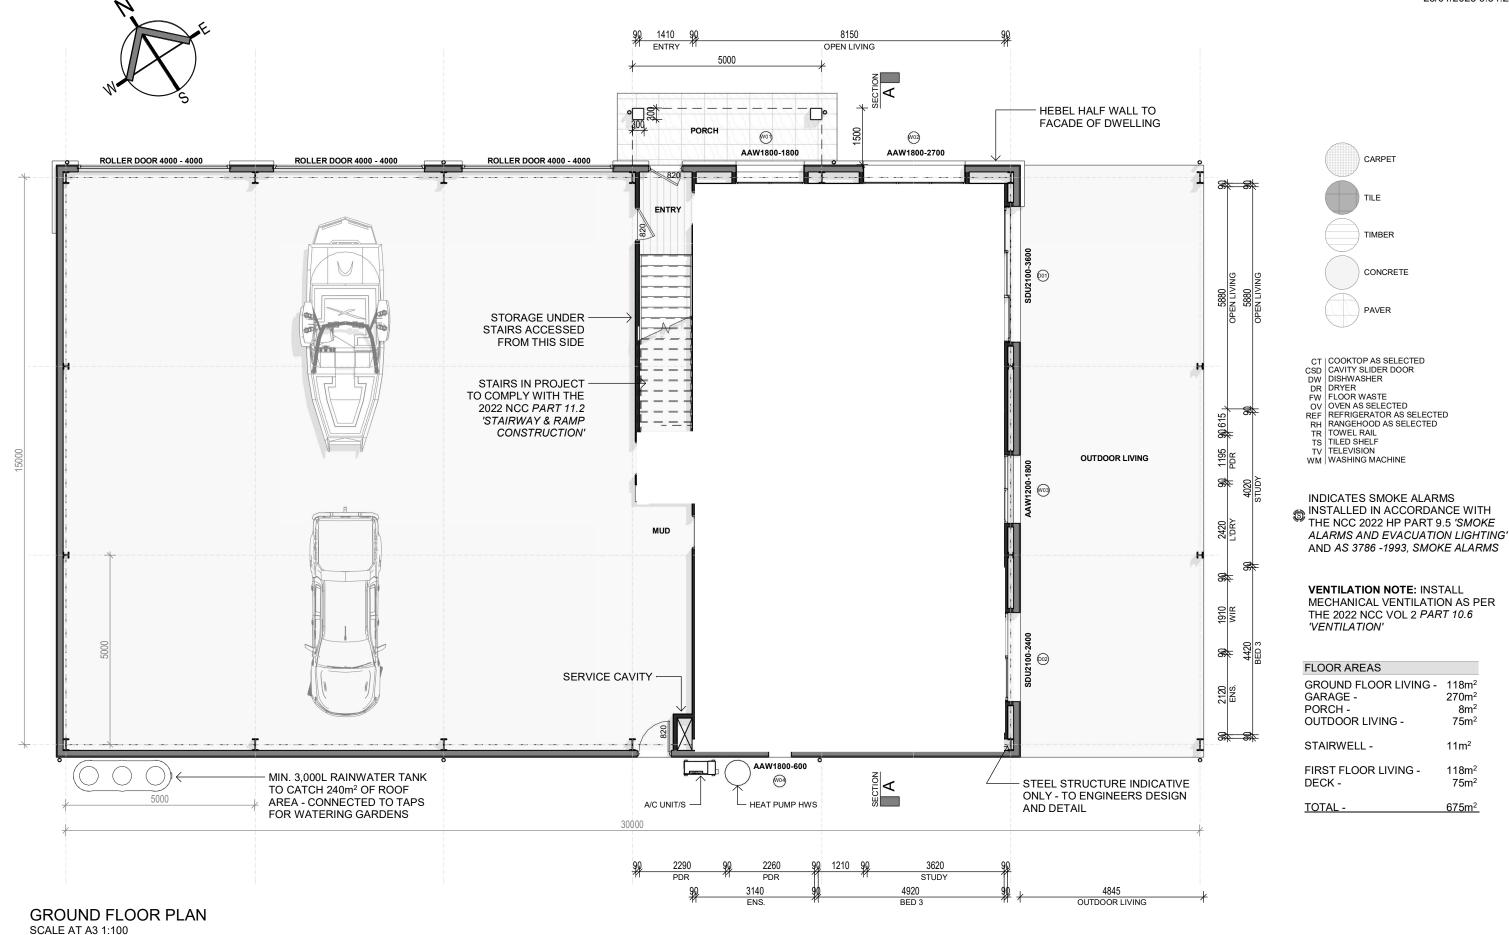




PROJECT
PROPOSED RESIDENCE
7 DE SALIS DRIVE
JUNEE NSW

DRAWING TITLE GROUND FLOOR PLAN CLIENT SHEATHER DATE // TIME 28/01/2025 9:54:22 AM

SCALE
AS SHOWN
REVISION NO.
A
PROJECT ID
35FED24



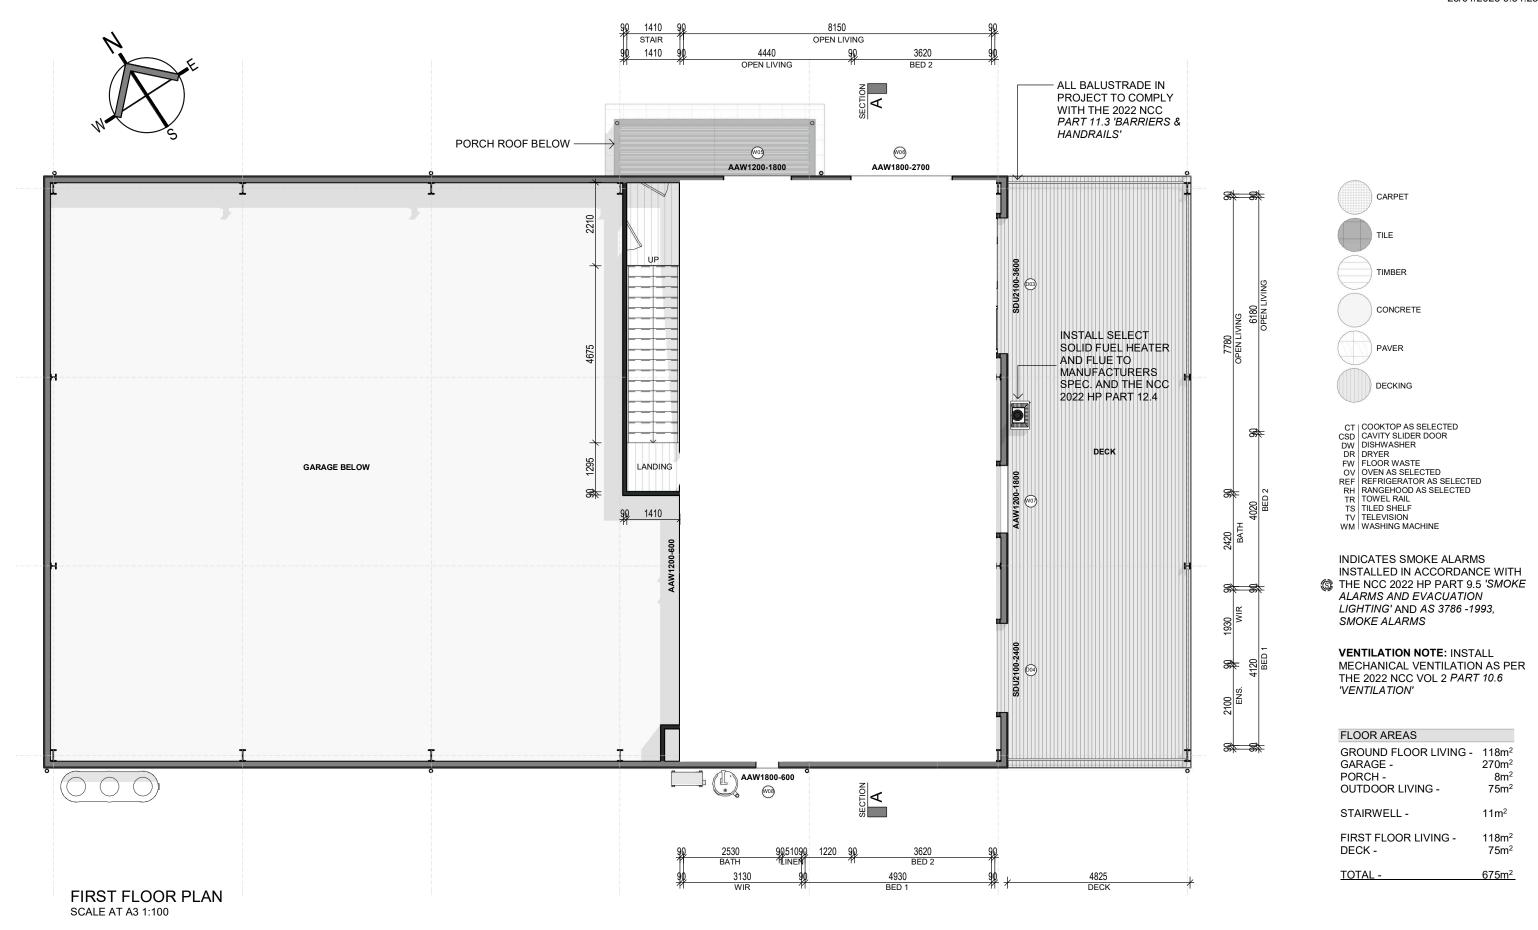




PROJECT
PROPOSED RESIDENCE
7 DE SALIS DRIVE
JUNEE NSW

DRAWING TITLE
FIRST FLOOR PLAN
CLIENT
SHEATHER
DATE // TIME
28/01/2025 9:54:23 AM

SCALE
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REVISION NO.
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PROJECT ID
35FED24





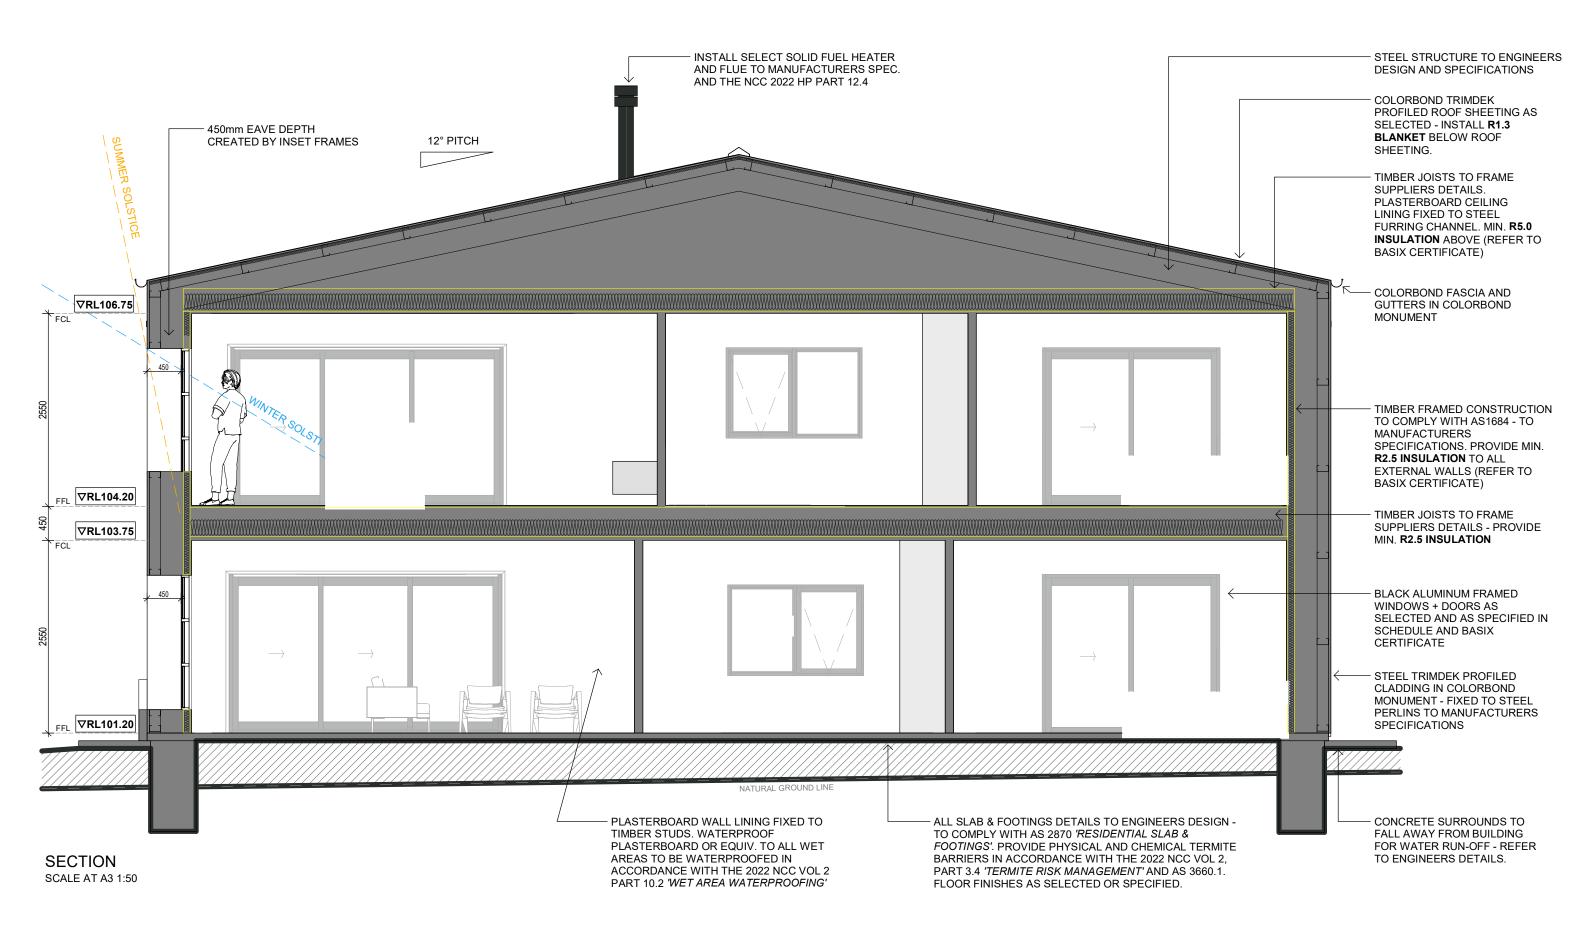



PROJECT
PROPOSED RESIDENCE
7 DE SALIS DRIVE
JUNEE NSW

DRAWING TITLE SECTION CLIENT SHEATHER DATE // TIME 28/01/2025 9:54:23 AM SCALE
AS SHOWN
REVISION NO.
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NORTHERN ELEVATION SCALE AT A3 1:100




SCALE AT A3 1:100


FINE EYE DESIGNS 0499 783 056 we.are@fineeyedesigns.com.au

PROJECT PROPOSED RESIDENCE 7 DE SALIS DRIVE JUNEE NSW

DRAWING TITLE ELEVATIONS CLIENT SHEATHER DATE // TIME 28/01/2025 9:54:26 AM SCALE
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A
PROJECT ID
35FED24 PROJECT ID 35FED24



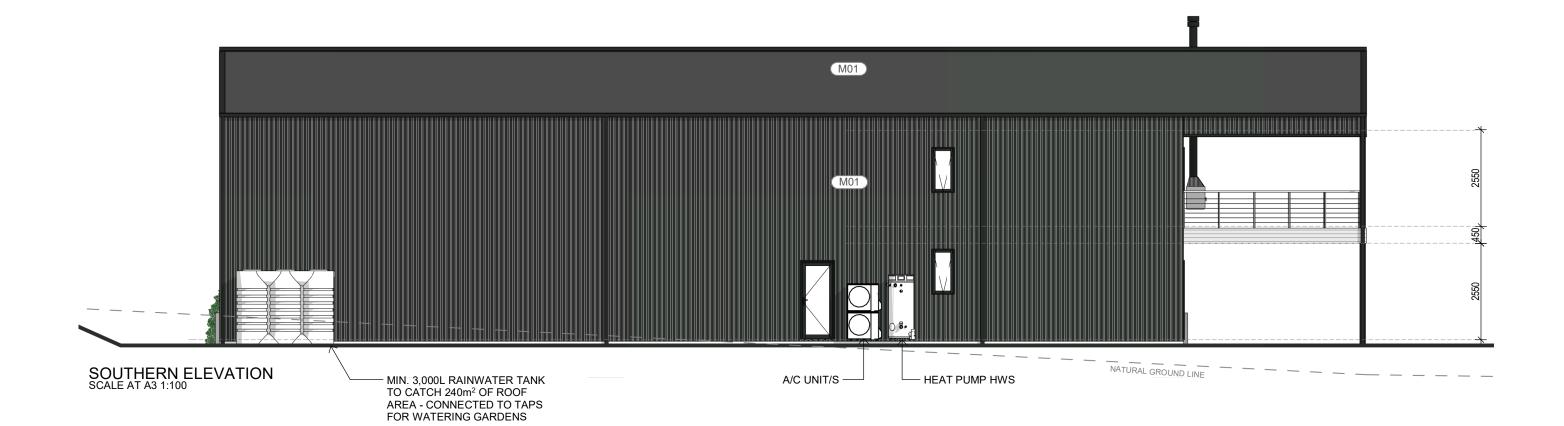

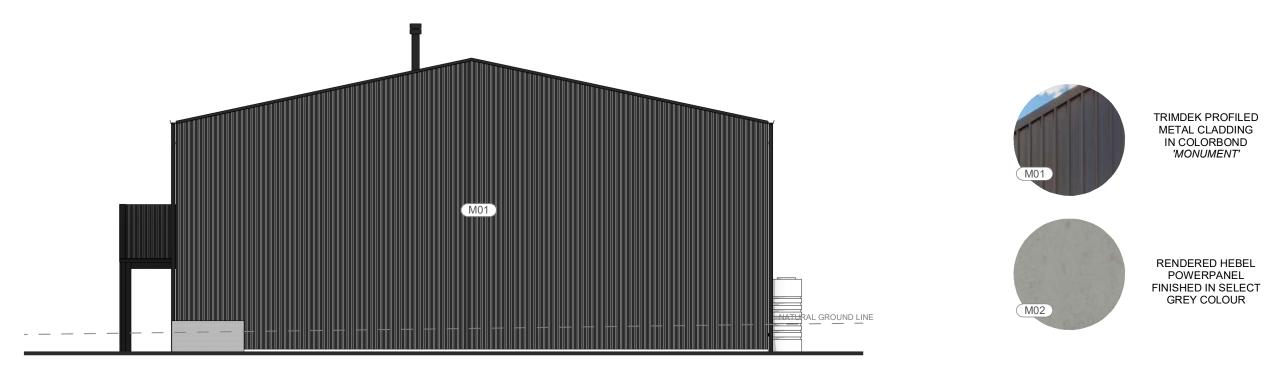

WESTERN ELEVATION SCALE AT A3 1:100



PROJECT
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7 DE SALIS DRIVE
JUNEE NSW

DRAWING TITLE
ELEVATIONS
CLIENT
SHEATHER
DATE // TIME
28/01/2025 9:54:29 AM

SCALE
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GLAZING SCHEDULE									
NO.	HEIGHT(mm)	WIDTH(mm)	HEAD(mm)	DESCRIPTION					
W01	1800	1800	2100	ALUMINIUM, CLEAR, AWNING WINDOW					
W02	1800	2700	2100	ALUMINIUM, CLEAR, AWNING WINDOW					
W03	1200	1800	2100	ALUMINIUM, CLEAR, AWNING WINDOW					
W04	1800	600	2100	ALUMINIUM, OBSCURE, AWNING WINDOW					
W05	1200	1800	2100	ALUMINIUM, CLEAR, AWNING WINDOW					
W06	1800	2700	2100	ALUMINIUM, CLEAR, AWNING WINDOW					
W07	1200	1800	2100	ALUMINIUM, CLEAR, AWNING WINDOW					
W08	1800	600	2100	ALUMINIUM, OBSCURE, AWNING WINDOW					
D01	2100	3600	2100	ALUMINIUM, CLEAR, SLIDING DOOR					
D02	2100	2400	2100	ALUMINIUM, CLEAR, SLIDING DOOR					
D03	2100	3600	2100	ALUMINIUM, CLEAR, SLIDING DOOR					
D04	2100	2400	2100	ALUMINIUM, CLEAR, SLIDING DOOR					

GLAZING NOTES

- ALL WINDOWS & GLAZED DOOR INSTALLATION TO COMPLY WITH AS 2047 AND AS 1288. BUSHFIRE PRONE AREAS TO COMPLY WITH AS 3959 REFER TO BUSHFIRE NOTES FOR BUSHFIRE ATTACK LEVEL (BAL) (IF APPLICABLE TO
- WINDOW FRAME AND GLAZING PERFORMANCE LEVELS TO MEET OR EXCEED BASIX CERTIFICATE REQUIREMENTS.
- BUILDER TO ADVISE FRAMING MANUFACTURER OF SELECTED WINDOW MANUFACTURERS AS STANDARD WINDOW SIZES VARY SLIGHTLY BETWEEN MANUFACTURERS.
- ALL WINDOW AND DOOR DIMENSIONS TO BE CHECKED ON SITE PRIOR TO FABRICATION.
- ALL OPERABLE WINDOWS TO BE FITTED WITH SEALS AND TIGHT FITTING FLY SCREENS.
 EXTERNAL DOORS TO BE FITTED WITH WEATHER SEALS ALL ROUND.

			Basix Require								
New Dwelling Prepared by Chapman Environmental Services											
7 De Salis Drive			www.cesenergy.com.au 1300 004 914 CHAPMA								
JUNEE	NSW	2663	1300 004 914				CHA	PMAN			
			1 2000 00 102 1				ENVIRONME	NIAL SERVICES			
Water Target		20	Water Score		20	Conditioned Area 2		254.5			
Energy Target		67	Energy Score		90	Unconditioned Area		7.6			
, , , , , , , , , , , , , , , , , , ,			l l								
Max H & C Loads are (N	MJ/m²)	94	Actual H & C Loads are	93.9	Star Rating 7.1						
THAK THE C LOCAS CITC (I	10/111/		rictual if a c Louas are (Mis/iii)		33.3	Total Hatilia		7.1			
Basix Commitments											
Landscaping	Total area o	of garden & I	awn (m²) 500		Area of indi	igenous/low water ι	use plants (m²)	100			
				'		,					
Fixtures	Shower heads		4 star (> 6 but <= 7.5 L/min)		Toilets	4 star	All taps	4 star			
								240			
	Minimum R	lainwater tai	k size (L) 3000		Collect ru	Collect run off from roof area of at least (m²)					
Alternative Water	Toilet connection		Laundry connection	Landscape	connection	Pool top up S		ор ир			
	No		No		'es	n/a		n/a			
		••	110			11/ 4		, u			
Pool and Spa	Max pool vo	olume (kL)	n/a								
		, ,	•								
	Hot water s		Electric heat pump - air				20 STCs				
	Bathroom ventilation Individual fan, ducted to facade or roof						ual switch on/off				
	Kitchen ven	itilation	Individual fan, ducted t	o facade or r	oof	with Man	ual switch on/off				
	Laundry ver	ntilation	Individual fan, ducted t	o facade or r	oof	with Man	ual switch on/off				
_		Cooling - living areas 3-phase airconditioning Rating EER 3.0 - 3.5						Zoned			
Energy		Cooling - bedrooms 3-phase airconditioning Rating EER 3.0 - 3.5 Heating - living areas 3-phase airconditioning Rating EER 3.0 - 3.5									
	Heating - bedrooms 3-phase airconditioning Rating EER 3.0 - 3.5										
	Alternate Energy Photovoltaic system able to generate at least Min 3.0 peak kilowatts of electricity										
	Electric cooktop & electric oven Outdoor clothesline required No indoor clothesline requ										
	Liectific coo	Ktop & elect	ilic overi	diador ciotii	iesiirie requii	eu No	muoor ciotilesiin	e required			
		Thormal Box	formance Assessment F	Pacad on the	Following P	loquiroments					
Floor Types	Thermal Performance Assessment Based on the Following Requirements Concrete slab on ground with No insulation required										
Floor Types	Concrete sia	ab on ground	u	with	NO Insulatio	on required					
	Tiles Lower Living / Lower bedroom / Wet areas Timber Upper Living / Upper bedrooms										
Floor Coverings	Carpet	n/a	g / Lower Beardon / W	ct areas	Concrete Garage						
	Tearper	TI/ a			Concrete	Garage					
External Walls	Timber fran	ned Metal cl	ad	with	Sarking and	R2.5 bulk insulation	n Colour	Dark			
Internal Walls	Plasterboard with R2.5 bulk insulation to garage internal walls only										
Ceiling (floor over)	Timber above plasterboard with R2.5 bulk insulation										
Cailings (no of aven)	Timber above placterboard										
Ceilings (roof over)	Timber above plasterboard. with R5.0 bulk insulation										
Roof	Metal		12 degrees	with	R1.3 roof b	lanket	Colour	Dark			
1.001	Interal		12 degrees	WILII	N1.5 1001 B	Idriket	Coloul	Daik			
	AF double g	lazed clear		Awning W		U-Value 5.40 c	or less SHGC 0.50) +/- 5%			
	_			Sliding D		U-Value 4.54 c					
Windows and Doors	to all windows	7. 1000 01.100 010	, .,								
	AF = Aluminium Framed TB = Thermally Broken Aluminium Framed TF = Timber Framed										
	If the Universal Certificate indicates downlights, then these are to be non-ventilated LED / fluorescent Any exhaust fans noted are to be fitted with self-closing dampers or be otherwise sealed										
All insulation specified must be installed in accordance with Part 3.12.1.1 of the BCA If there is a discrepancy between this document and the Nathers Certificate, then the Nathers Certificate shall take precedence											
	., is a ai.	- cpaney betv		certifie	and the five		procedure.				



PROPOSED RESIDENCE 7 DE SALIS DRIVE JUNEE NSW

DRAWING TITLE
GLAZING SCHEDULE + BASIX SHEATHER DATE // TIME 28/01/2025 9:54:29 AM

AS SHOWN REVISION NO. Α PROJECT ID 35FED24



